
# SITE IMPROVEMENT & BUILDING PLANS

PREPARED FOR:

## NOURIA ENERGY CORPORATION

264 TIMPANY BLVD. GARDNER, MA

PREPARED BY:

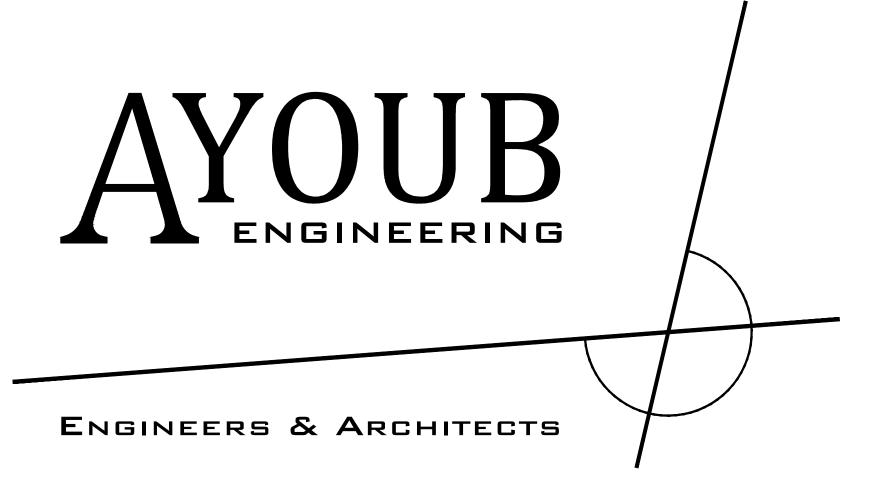

414 BENEFIT STREET
PAWTUCKET, RHODE ISLAND 02861
401-728-5533

P.O. Box 514 Exeter, New Hampshire 03833 603-765-1001


INDEX OF DRAWINGS SHEET TITLE **GENERAL** COVER EXISTING CONDITIONS PLAN SITE DEMOLITION PLAN SITE IMPROVEMENT PLAN SITE GRADING PLAN SITE UTILITY PLAN SITE LANDSCAPE PLAN SITE DETAIL SHEET SD-2SITE DETAIL SHEET SD-3SITE DETAIL SHEET SG-2PROPOSED SIGNAGE PLAN PROPOSED SIGNAGE PLAN **ARCHITECTURAL ELEVATIONS** 

SITE IMPROVEMENT & BUILDING PLANS

PREPARED FOR:


NOURIA ENERGY CORPORATION

264 TIMPANY BLVD. GARDNER, MA

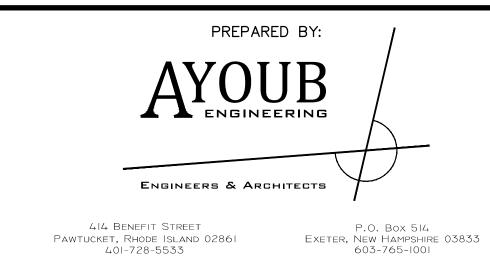

PROJECT NO. 1623

DATE: 12/20/2013

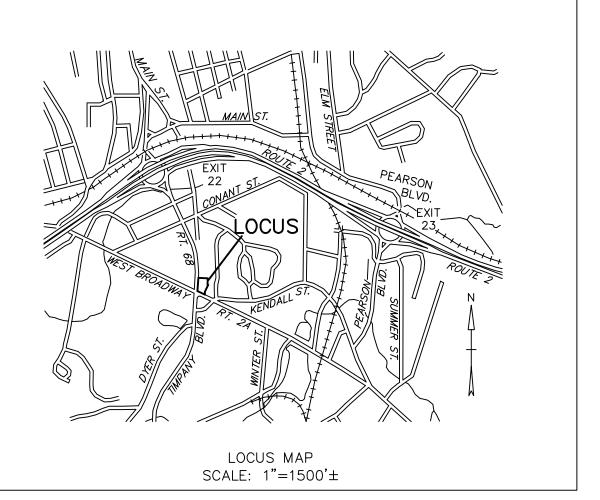

1. DEED REFERENCES: MARCIA L. FLANAGAN

2. PLAN REFERENCES: P.B. 44, P. 55

MIN. LOT AREA:

MIN. LOT FRONTAGE:

MIN. SIDE SETBACK:

DATED JULY 2, 1981.

ELEVATION.

MIN. FRONT SETBACK:

MIN. REAR SETBACK:

NOT BE REFLECTED ON THIS PLAN.

EXCAVATION AND CONSTRUCTION.

BK. 23984, P. 317

BK. 43203, P. 217

BK. 42103, P. 285

3. THE SUBJECT PREMISES ARE GRAPHICALLY SITUATED IN THE SINGLE

SINGLE FAM RES 1

12,500 S.F.

4. THE SUBJECT PREMISES ARE NOT GRAPHICALLY SITUATED IN THE

DATA ACCUMULATION SURVEY PERFORMED BY WHITMAN & BINGHAM

6. ALL UTLITIES SHOWN HEREON SHALL BE CONSIDERED APPROXIMATE.

7. ALL UTILITY SERVICES ARE NOT SHOWN ON THIS PLAN. CONTRACTOR SHALL CONTACT THE APPROPRIATE UTILITY COMPANY FOR LOCATION AND

CONTRACTOR SHALL VERIFY LOCATION AND ELEVATION PRIOR TO

100 FT.

30 FT.

15 FT.

20 FT.

P.B. 60, P. 34 P.B. 256, P. 67 P.B. 265, P. 63 P.B. 366, P. 50

THE FOLLOWING MINIMUM DIMENSIONAL REQUIREMENTS:

PATRICIA J. HANNULA ET AL

TSTES. MARY A DEVEIKIS O7 REVOCABLE TRUST


30,000 S.F.

100 FT.

30 FT.

20 FT.

30 FT.

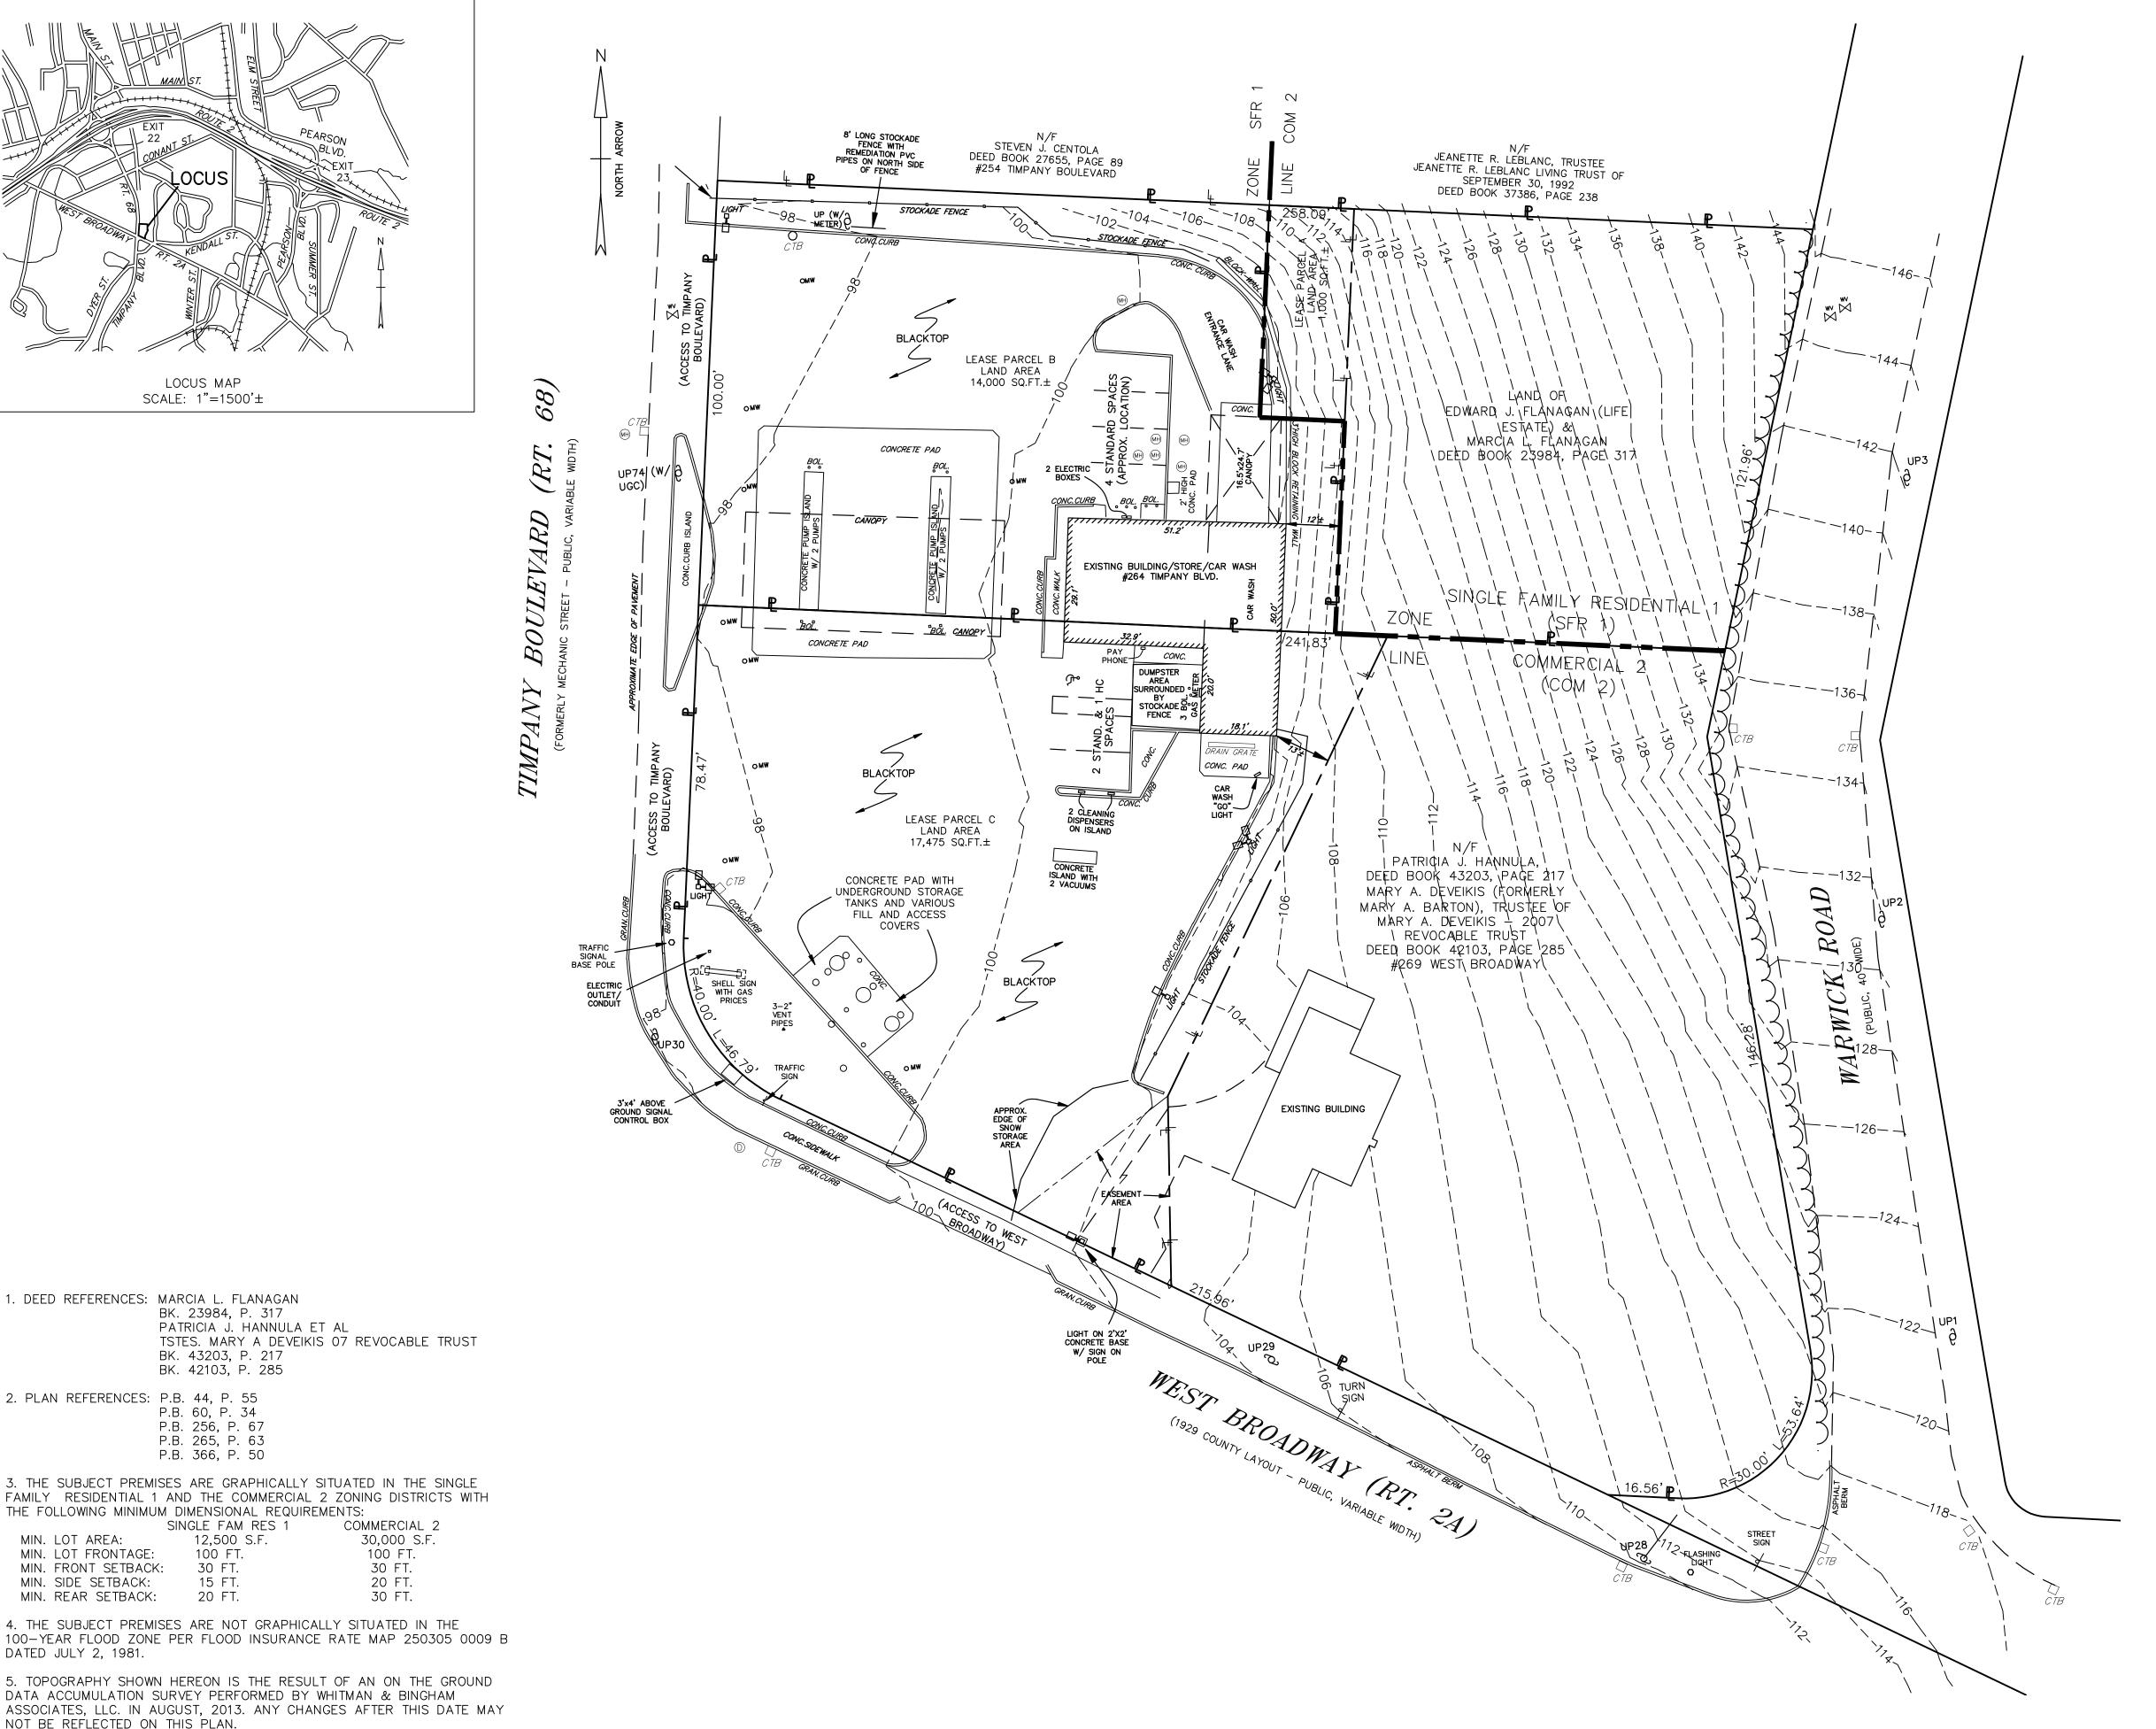

LEGEND

WATER VALVE (WV) UTILITY POLE (UP) つ LEASE LINE CATCHBASIN (CTB) □ SEWER MANHOLE (SMH) S DRAIN MANHOLE (DMH) MANHOLE COVER (MH) BOLLARD (BOL.) •BOL. MONITORING WELL (MW) OMW PIPE / ROD SURVEY MONUMENT • CONCRETE (CONC.) GRANITE (GRAN.) UNDERGROUND (UG) UNDERGROUND CONDUIT (UGC) OVERHEAD (OH) 

EXISTING CONDITIONS PLAN

IN GARDNER, MA


PREPARED FOR


NOURIA ENERGY CORPORATION

AUGUST 22, 2013

WHITMAN & BINGHAM ASSOCIATES, LLC REGISTERED PROFESSIONAL ENGINEERS & LAND SURVEYORS

510 MECHANIC STREET - LEOMINSTER, MASSACHUSETTS 01453

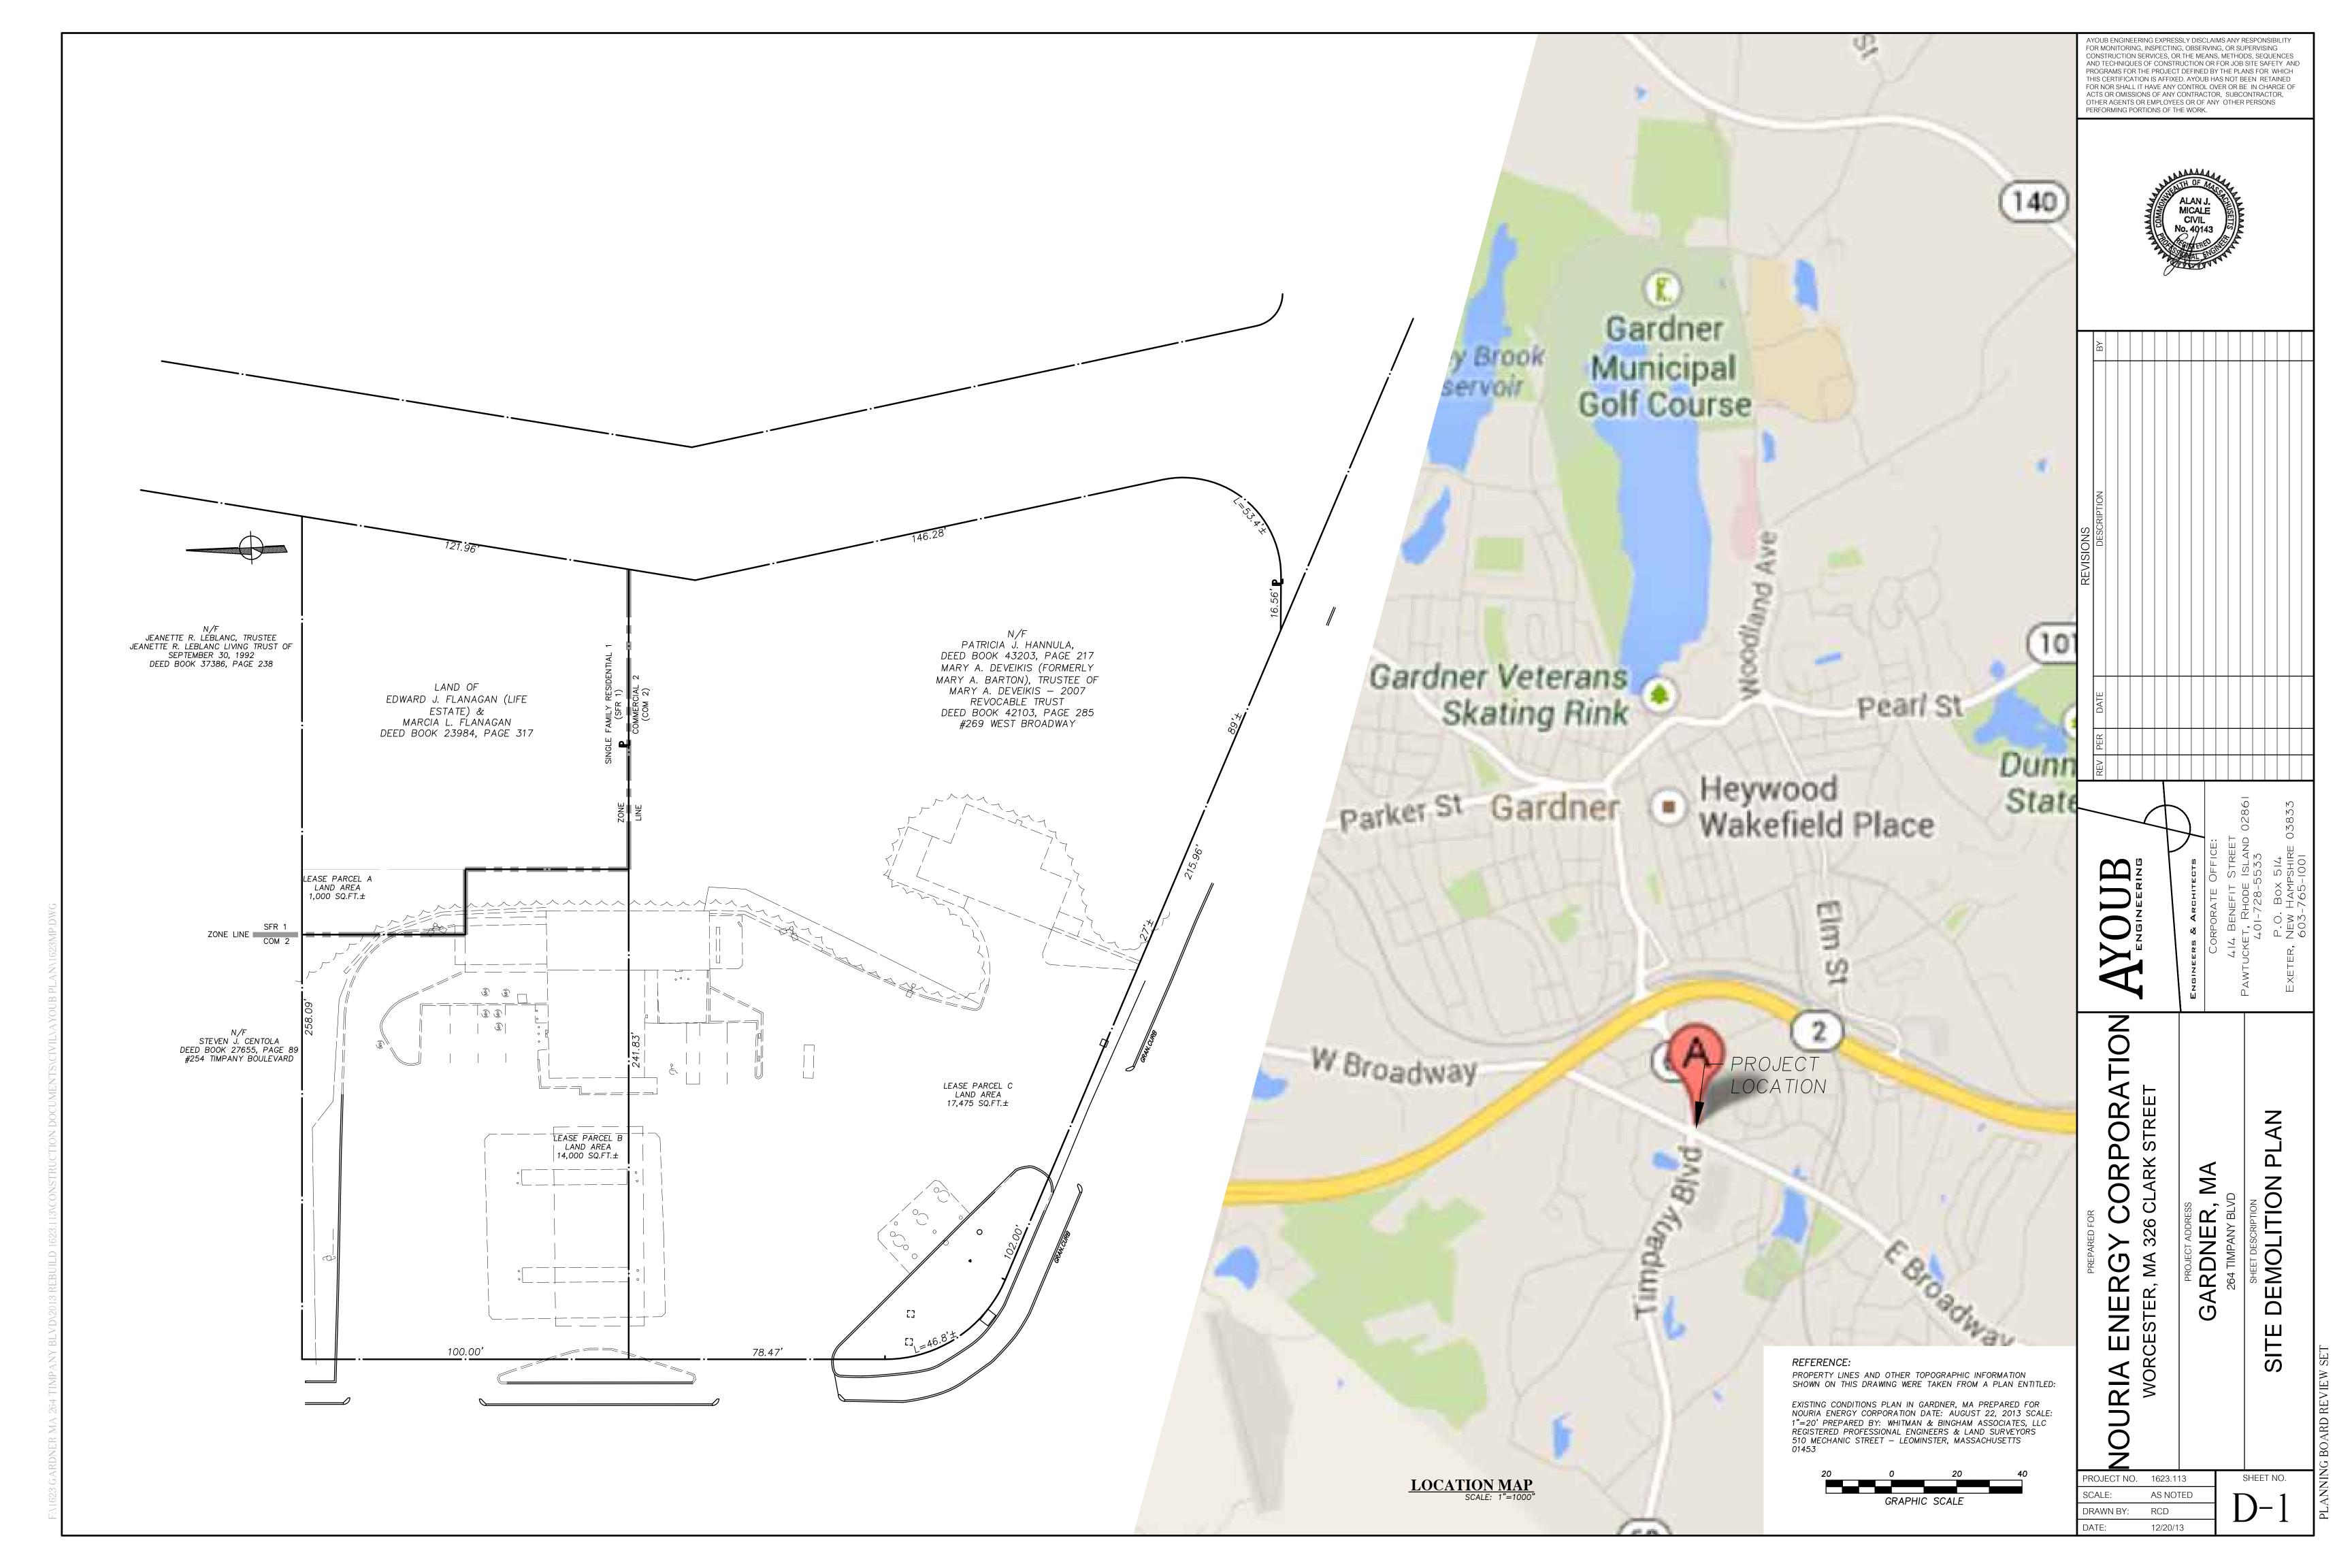

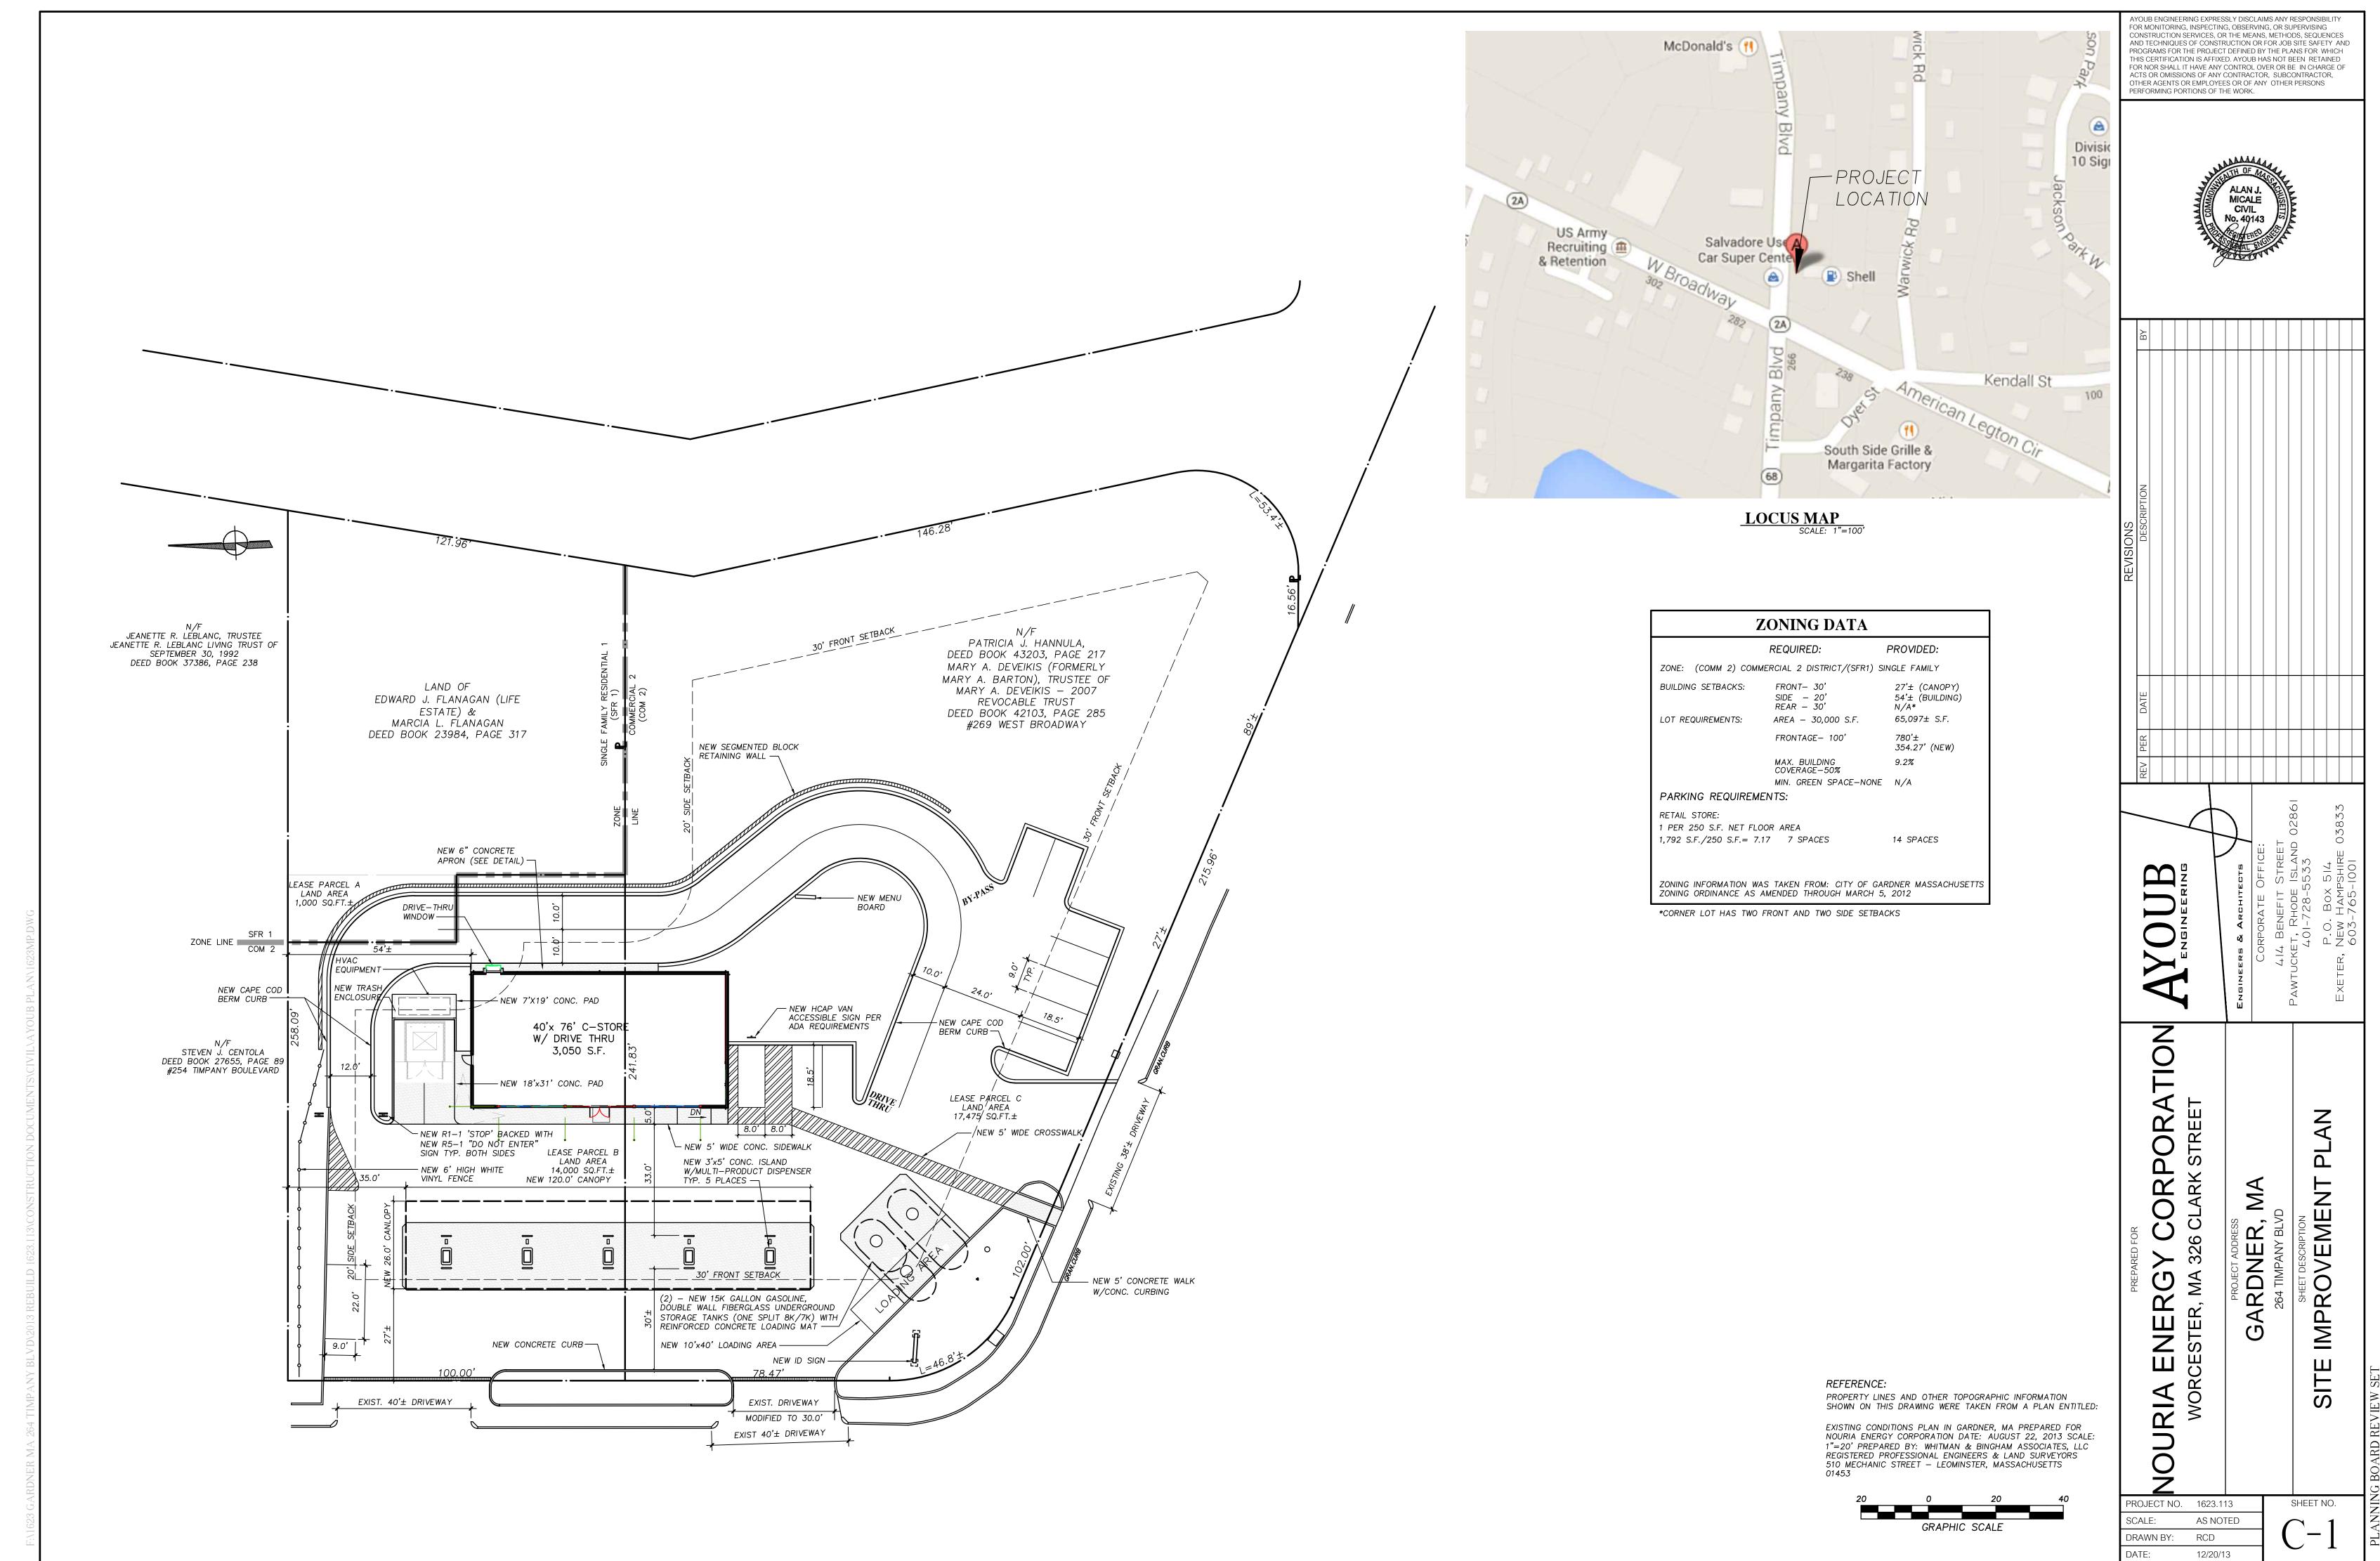

PROJECT NO. 1623.113 AS NOTED RCD 12/20/13

SHEET NO.

ARDNE

AYOUB ENGINEERING EXPRESSLY DISCLAIMS ANY RESPONSIBILITY FOR MONITORING, INSPECTING, OBSERVING, OR SUPERVISING CONSTRUCTION SERVICES, OR THE MEANS, METHODS, SEQUENCES AND TECHNIQUES OF CONSTRUCTION OR FOR JOB SITE SAFETY AND

PROGRAMS FOR THE PROJECT DEFINED BY THE PLANS FOR WHICH

#### BIORETENTION AREA NOTES:

- 1. BIORETENTION AREA PLANTS ARE TO BE PLANTED IN RANDOM GROUPS OF 5, COVERING 30%-50% OF THE DEFINED AREA.
- 2. A. SOIL IS TO BE A SAND/COMPOST/SOIL MIX CONTAINING 40% SAND, 20-30% TOPSOIL, AND 30-40% COMPOST BY VOLUME WITH A CLAY CONTENT OF LESS THAN 5% BY VOLUME. THE SOILS SHALL BE FREE OF STONES, STUMPS, ROOTS AND OTHER WOODY MATERIAL AND BRUSH. SOIL SHALL ALSO BE FREE OF SEEDS FROM
- B. SOIL PH SHOULD GENERALLY BE BETWEEN 5.5-6.5.
- C. SOIL TO HAVE 1.5%-3% ORGANIC CONTENT AND MAX. 500-PPM SOLUBLE SALTS.
- D. THE SAND COMPONENT SHOULD BE GRAVELLY SAND THAT MEETS ASTM D 422.
- E. THE TOPSOIL SHALL BE A SANDY LOAM, LOAMY SAND OR LOAM TEXTURE.
- F. THE COMPOST COMPONENT MUST BE PROCESSED FROM YARD WASTE IN ACCORDANCE WITH MASSDEP GUIDELINES, AND SHALL NOT CONTAIN BIOSOLIDS.
- 3. SOIL IS TO BE 2' MIN. IN DEPTH, PLACED IN LIFTS OF 12 INCHES, AND LOOSELY COMPACTED SUCH AS BY LIGHTLY TAMPING WITH A DOZER OR BACKHOE BUCKET.
- 4. THE MULCH FOR THE AREA SHALL BE SHREDDED HARDWOOD MULCH THAT HAS BEEN WELL AGED (STOCKPILED OR STORED FOR AT LEAST SIX MONTHS), UNIFORM IN COLOR, AND FREE OF OTHER MATERIALS SUCH AS WEED SEEDS, SOIL, ROOTS ETC. THE MULCH SHALL BE APPLIED TO A DEPTH OF 3 INCHES, AND LEFT 2 INCHES AWAY FROM PLANT TRUNKS.
- 5. A DENSE AND VIGOROUS VEGETATIVE COVER SHALL BE ESTABLISHED OVER THE SWALE BEFORE RUNOFF CAN BE EXCEPTED INTO THE BIORETENTION AREA.

#### BIORETENTION AREA MAINTENANCE:

- 1. A LEGALLY BINDING AND ENFORCEABLE MAINTENANCE AGREEMENT SHALL BE EXECUTED BETWEEN THE FACILITY OWNER AND THE RESPONSIBLE AUTHORITY TO ENSURE THE FOLLOWING:
- A. TRASH AND DEBRIS SHALL BE REMOVED AS NECESSARY.
- B. SILT/SEDIMENT SHALL BE REMOVED WHEN THE ACCUMULATION EXCEEDS ONE INCH. WHEN THE FILTERING CAPACITY DIMINISHES SUBSTANTIALLY (I.E. WHEN WATER PONDS ON THE SURFACE FOR MORE THAN 48 HOURS) THE TOP FEW INCHES OF DISCOLORED MATERIAL SHALL BE REMOVED AND REPLACED WITH FRESH MATERIAL. THE REMOVED SEDIMENTS SHALL BE DISPOSED OF IN AN ACCEPTABLE MANNER AT AN APPROVED AND PERMITTED LOCATION.
- 2. DURING THE SIX MONTHS AFTER CONSTRUCTION, THE BIORETENTION AREA SHALL BE INSPECTED FOLLOWING AT A MINIMUM THE FIRST TWO STORM EVENTS OF AT LEAST 1" TO ENSURE THE SYSTEM IS FUNCTIONING PROPERLY. THEREAFTER, INSPECTIONS SHALL BE CONDUCTED ON AN ANNUAL BASIS AND AFTER STORM EVENTS OF GREATER THAN OR EQUAL TO THE 1 YEAR, 24-HOUR TYPE III EVENT.
- 3. THE ADJACENT GRASS COVER SHOULD BE MOWED A MINIMUM OF 3 TIMES PER GROWING SEASON TO MAINTAIN MAXIMUM GRASS HEIGHTS OF 12"
- 4. THE BIORETENTION AREA WOODY VEGETATION SHOULD BE PRUNED OR REPLACED WHEN DEAD OR DYING VEGETATION IS OBSERVED. SEPARATION OF HERBACEOUS VEGETATION ROOTSTOCK SHOULD OCCUR WHEN OVER-CROWDING IS OBSERVED, OR APPROXIMATELY ONCE EVERY THREE YEARS. IF AT LEAST 50 PERCENT VEGETATION COVERAGE IS NOT ESTABLISHED AFTER TWO YEARS, A REINFORCEMENT PLANTING
- 5. THE MULCH LAYER SHOULD BE REPLENISHED (TO THE ORIGINAL DESIGN DEPTH) EVERY OTHER YEAR, AS DIRECTED BY INSPECTION REPORTS. THE PREVIOUS MULCH LAYER SHOULD BE REMOVED AND PROPERLY DISPOSED OF, OR ROTO-TILLED INTO
- 6. MINOR SOIL EROSION GULLIES SHOULD BE REPAIRED WHEN THEY OCCUR.

40'x 76' C-STOF

W/ DRIVE THRU 3,050 S.F.

BIORETENTION AREA PLANT LIST							
BOTANICAL NAME	COMMON NAME	QUAN. SPACING		SIZE			
ASTER NOVAE-ANGLIAE	NEW ENGLAND ASTER	25	I 1/2' O.C.	1 GAL.			
COREOPSIS SPECIES	COREOPSIS	20	I 1/2' O.C.	1 GAL.			
ERAGROSTIS SPECTABILIS	PURPLE LOVEGRASS	40	I 1/2' O.C.	1 GAL.			
EUPATORIUM MACULATUM	JOE-PYE WEED	20	I 1/2' O.C.	1 GAL.			
IRIS VERSICOLOR	BLUE FLAG	25	I 1/2' O.C.	1 GAL.			
RUDBECKIA HIRTA	BLACK EYED SUSAN	25	I 1/2' O.C.	1 GAL.			
SOLIDAGO VIRGAUREA	GOLDENROD	40	I 1/2' O.C.	1 GAL.			
PHLOX STOLONIFERA	PHLOX PURPLE	40	I 1/2' O.C.	1 GAL.			
CAREX STRICTA	TUSSOCK SEDGE	20	I 1/2' O.C.	1 GAL.			

EXISTING TREE MASS TO REMAIN

BIORETENTION AREA

**PLANTINGS** 

РММ

OUTLET CONTROL WEIR PLATE WITH (1) 1 ORIFICE AT ELEV. 99.39 IN NYLOPLAST WATER CONTROL STRUCTURE W/DUCTILE IRON INLET GRATE - RIM =100.00 -

- EXISTING LANDSCAPING

PLANT LIST								
KEY	BOTANICAL NAME	COMMON NAME	QUAN.	SIZE	ROOT			
РММ	PINUS MUGO MUGO	DWARF MUGO PINE	8	2'-2 1/2' HT.	2 GAL.			
TC	TAXUS CUSPIDATA DENSIFORMIS	DENSE YEW	9	3'-4' HT.	B + B			
PJM	RHODODENDRON PJM	PJM	5	2'-2 1/2' HT.	2 GAL.			
IC	ILEX CRENATA 'COMPACTA'	COMPACT JAPANESE HOLLY	6	2'-2 1/2' HT.	2 GAL.			
CA	COTONEASTER APICULATUS	CRANBERRY COTONEASTER	10	1 1/2'-2' HT.	2 GAL.			
AZ	AZALEA HINOCRIMSON	AZALEA	5	1 1/2'-2' HT.	1 GAL.			
VD	VIBURNUM DENTATUM	ARROWWOOD VIBURNUM	3	3'-4' HT.	B + B			
PF	PIERIS FLORIBUNDA	MOUNTAIN ANDROMEDA	5	2'-2 1/2' HT.	2 GAL.			
CS	CORNUS SERICEA	RED OSIER DOGWOOD	7	2'-2 1/2' HT.	2 GAL.			
IG	ILEX GLABRA	INK BERRY	5	2'-2 1/2' HT.	2 GAL.			
WF	WEIGELA FLORIDA	WEIGELA	3	2'-2 1/2' HT.	2 GAL.			


#### GENERAL LANDSCAPE NOTES:

DEPTH OF SHREDDED HARDWOOD BARK.

- 1. ALL PLANT MATERIALS ARE TO BE FIRST QUALITY NURSERY STOCK, FREE FROM DISEASE OR OBJECTIONABLE DISFIGUREMENTS, AND PLANTED IN CONFORMANCE WITH SOUND NURSERY PRACTICE.
- 2. ALL NEW TREES ARE TO BE STAKED WITH TWO 8 FT. HARDWOOD STAKES, GUYED PER DETAIL.
- 3. AREAS SHOWN MULCHED ARE TO BE MULCHED WITH A MINIMUM 3 INCH


ADEQUATE AND TIMELY CARE DURING THE GUARANTEE PERIOD.

- 4. ALL PLANT MATERIALS ARE TO BE GUARANTEED FOR TWO (2) YEARS TO BE IN HEALTHY AND VIGOROUS CONDITION. IT IS UNDERSTOOD THAT THE OWNER WILL PROVIDE
- 5. ALL PLANTING PITS ARE TO RECEIVE 3 AGRIFORM TABS (3-YEAR FERTILIZER) AT TIME OF PLANTING.
- 6. PLANTS ARRANGED IN CONTINUOUS GROUPING ARE TO BE SET IN MULCHED BEDS. MULCH WILL BE A MIN. 3 INCH DEPTH OF SHREDDED HARDWOOD BARK.
- 7. ANY TREES OR SHRUBS DISTURBED FOR NEW WORK ARE TO BE PROTECTED AND OR REPLACED.
- 8. ALL EXISTING TREES AND SHRUBS INDICATED ON DRAWING ARE TO REMAIN UNLESS NOTED.

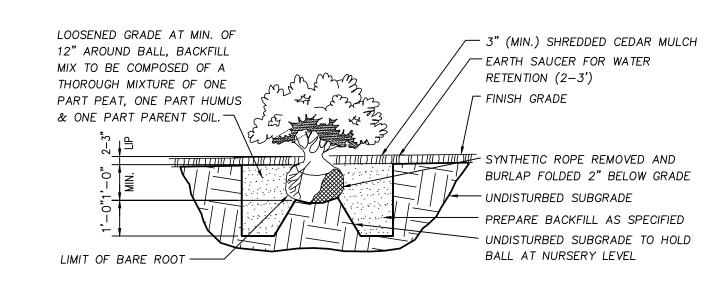

### SHRUB PLANTING DETAIL

NOT TO SCALE

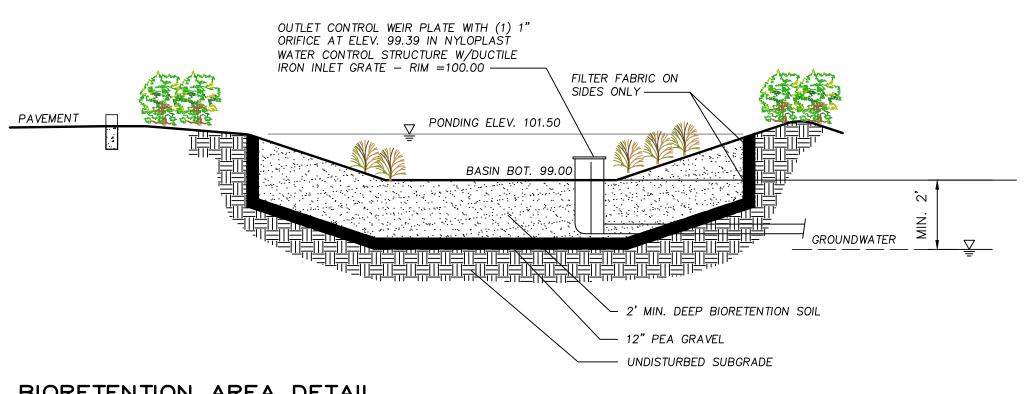


BIORETENTION AREA DETAIL

NOT TO SCALE

PROPERTY LINES AND OTHER TOPOGRAPHIC INFORMATION SHOWN ON THIS DRAWING WERE TAKEN FROM A PLAN ENTITLED:

EXISTING CONDITIONS PLAN IN GARDNER, MA PREPARED FOR NOURIA ENERGY CORPORATION DATE: AUGUST 22, 2013 SCALE: 1"=20' PREPARED BY: WHITMAN & BINGHAM ASSOCIATES, LLC REGISTERED PROFESSIONAL ENGINEERS & LAND SURVEYORS 510 MECHANIC STREET - LEOMINSTER, MASSACHUSETTS

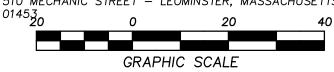


1623.113 SHEET NO. AS NOTED DRAWN BY: RCD 12/20/13

YOUB ENGINEERING EXPRESSLY DISCLAIMS ANY RESPONSIBILITY FOR MONITORING, INSPECTING, OBSERVING, OR SUPERVISING CONSTRUCTION SERVICES, OR THE MEANS, METHODS, SEQUENCES AND TECHNIQUES OF CONSTRUCTION OR FOR JOB SITE SAFETY AND PROGRAMS FOR THE PROJECT DEFINED BY THE PLANS FOR WHICH


THIS CERTIFICATION IS AFFIXED. AYOUB HAS NOT BEEN RETAINED FOR NOR SHALL IT HAVE ANY CONTROL OVER OR BE IN CHARGE OF

ACTS OR OMISSIONS OF ANY CONTRACTOR. SUBCONTRACTOR. OTHER AGENTS OR EMPLOYEES OR OF ANY OTHER PERSONS

PERFORMING PORTIONS OF THE WORK.

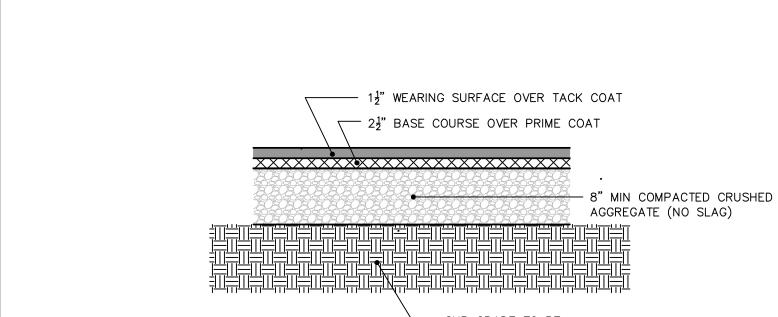


— SUB GRADE TO BE MODIFIED 95 PROCTOR MIN COMPACTION PAVEMENT SECTION DETAIL Not to Scale

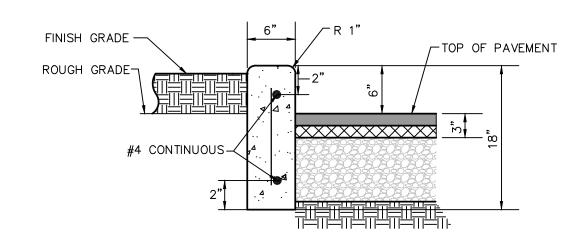


PROVIDE EXPANSION JOINTS @ 20'-0" O.C. (MAX)

6" x 18" CONCRETE CURB

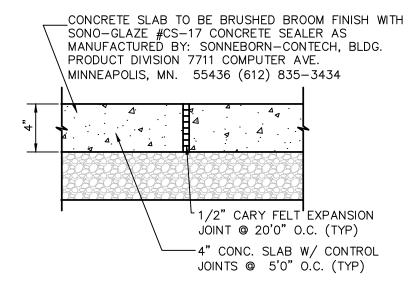


BRUSHED CONCRETE SIDEWALK TREATMENT DETAILS

Not to Scale

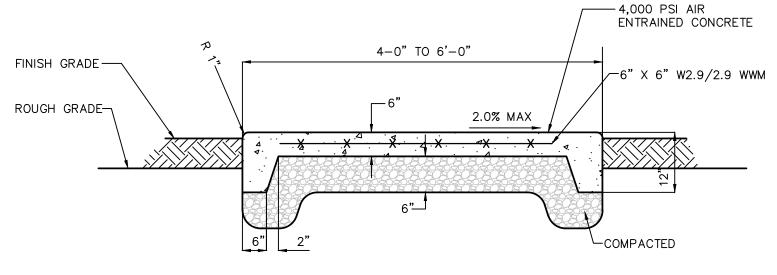


4' to 6' SIDEWALK Not to Scale

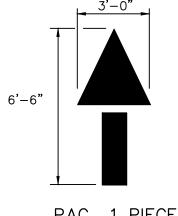

PH HEAD

PAC 1 PIECE ARROW

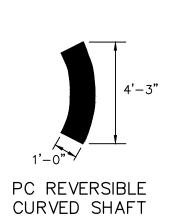


PS SHAFT

NOTES: 1. TYPES ALIGN CENTER 2. COLOR TO BE WHITE 3. MEETS NOT STATE OR FEDERAL STANDARDS


PARKING LOT ARROWS

5-3/4" DRIVE THRU & ARROW

> NOTE: TYPES ALIGNS CENTER

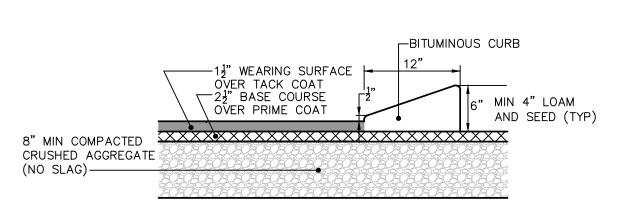


CAPE COD CURB Not to Scale

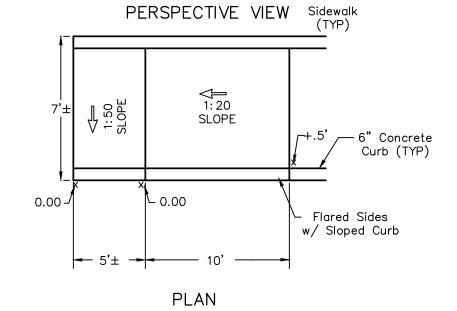


HANDICAP CURB RAMP DETAIL



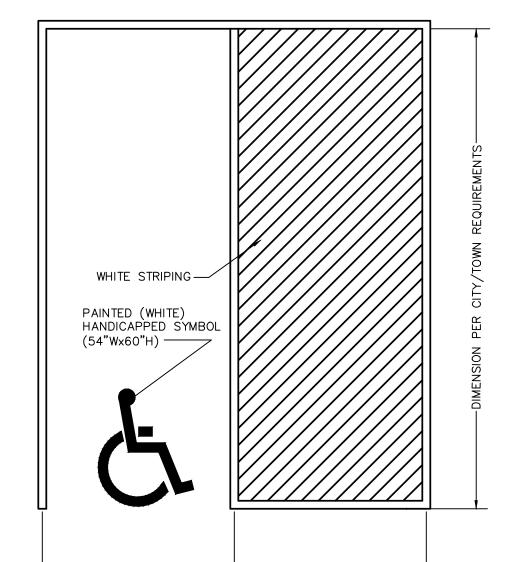


 REFER TO THE SITE PLAN (C-1) FOR SPECIFIC LOCATION AND CONFIGURATION. ADJUST FOR ANGLED PARKING.
 CONTRACTOR IS TO ENSURE THAT A MAXIMUM SLOPE OF 2.0% BE MAINTAINED IN ALL ADA PARKING AREAS. THE MAXIMUM RUNNING SLOPE ALLOWED FOR ANY PART OF A SIDEWALK OR ACCESSIBLE ROUTE IS 5%.
 THE MAXIMUM CROSS SLOPE ALLOWED FOR ANY PART OF A SIDEWALK OR ACCESSIBLE ROUTE IS 2%.

TYPICAL HANDICAP PARKING STALL STRIPING

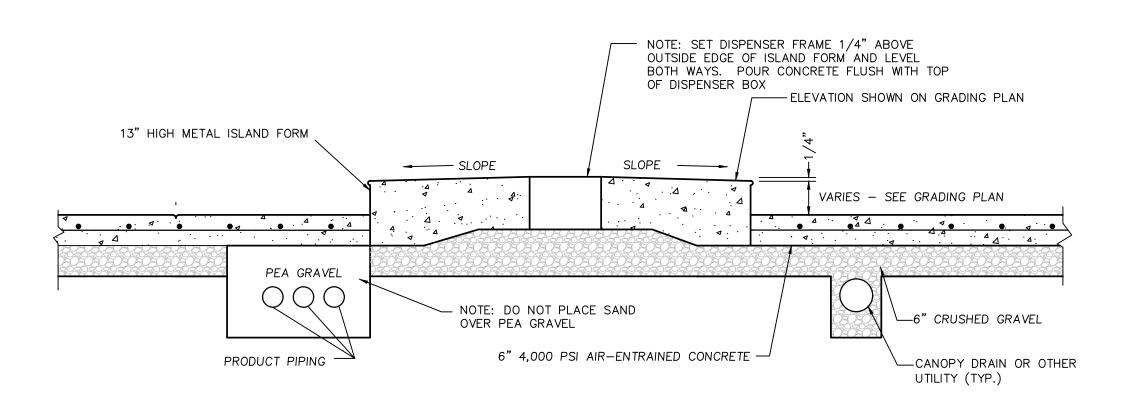

Not to Scale

SCTION THRU PUMP ISLAND Not to Scale

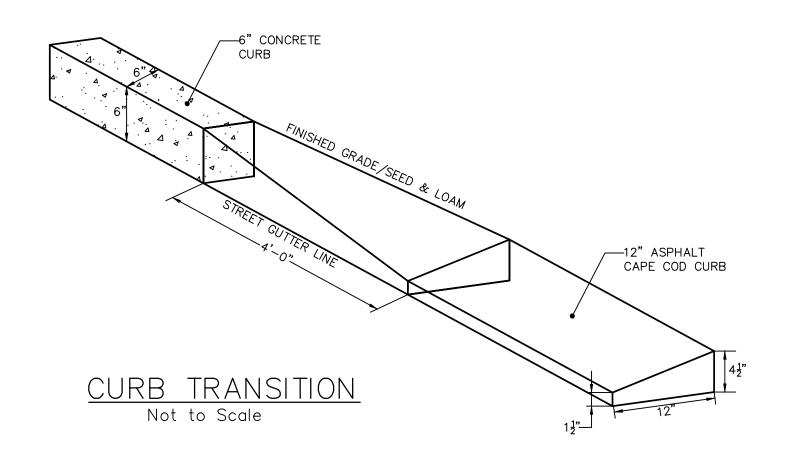

LED FIXTURE CLEAR ,FLAT, TEMPERED GLASS LENS LREAR REFLECTOR EXTRUDED ALUMINUM MOUNTING ARM FINISHED TO MATCH FIXTURE - 4" SQ. 11 GA. STEEL POST. FINISHED TO MATCH FIXTURE TWO PIECE ALUMINUM BASE COVER, FINISHED TO MATCH FIXTURE - CONCRETE FOUNDATION & REINFORCEMENT PER MANUFACTURER'S RECOMMENDATIONS SITE LIGHT DETAIL

Not to Scale

(OR AS REQUIRED BY CODE)

SHEET NO.

YOUB ENGINEERING EXPRESSLY DISCLAIMS ANY RESPONSIBILITY FOR MONITORING, INSPECTING, OBSERVING, OR SUPERVISING CONSTRUCTION SERVICES, OR THE MEANS, METHODS, SEQUENCES AND TECHNIQUES OF CONSTRUCTION OR FOR JOB SITE SAFETY AND PROGRAMS FOR THE PROJECT DEFINED BY THE PLANS FOR WHICH

THIS CERTIFICATION IS AFFIXED. AYOUB HAS NOT BEEN RETAINED

FOR NOR SHALL IT HAVE ANY CONTROL OVER OR BE IN CHARGE OF ACTS OR OMISSIONS OF ANY CONTRACTOR, SUBCONTRACTOR, OTHER AGENTS OR EMPLOYEES OR OF ANY OTHER PERSONS PERFORMING PORTIONS OF THE WORK.


SH ARDNER 


S

PROJECT NO. 1623.113 SCALE: AS NOTED DRAWN BY:


~

12/20/2013

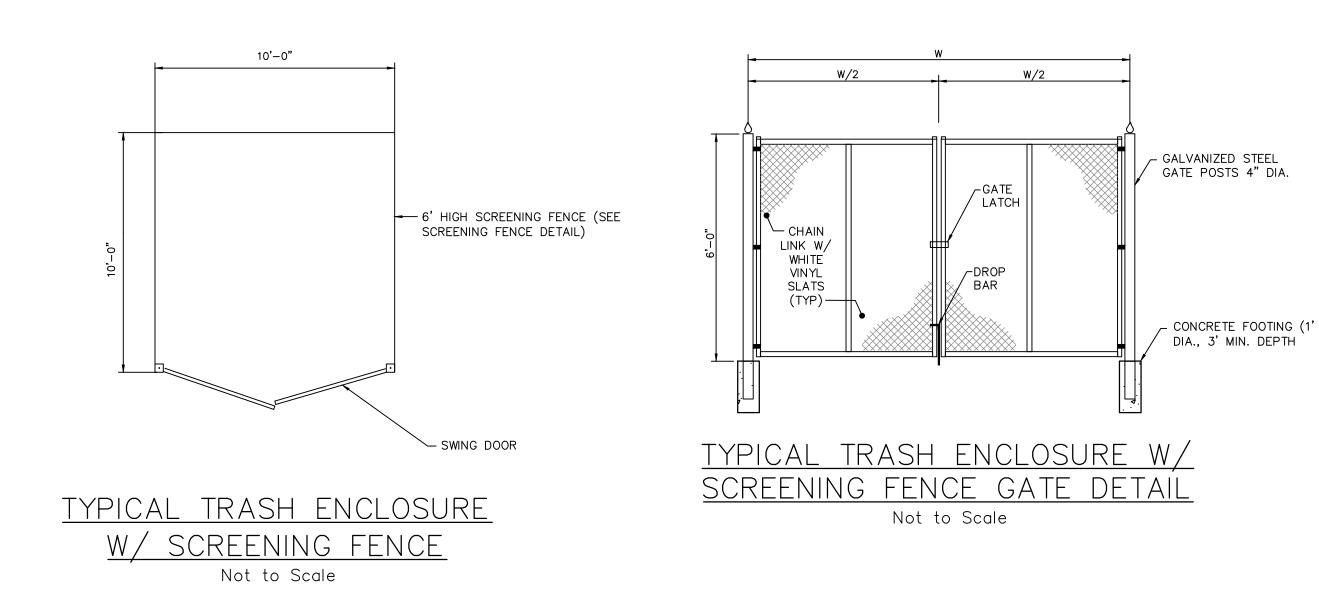


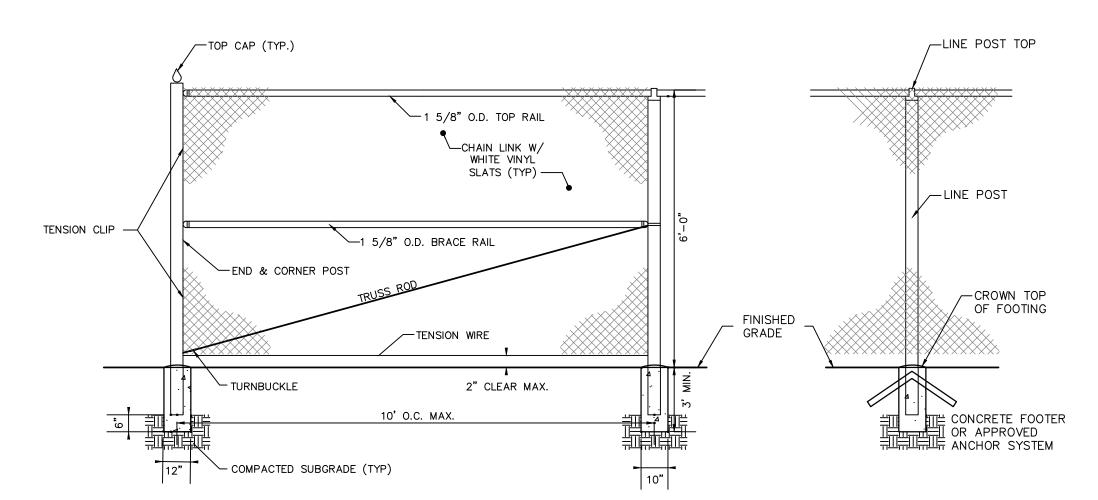

TYPICAL TRASH ENCLOSURE W/ SCREENING FENCE ELEVATION & POST DETAIL Not to Scale

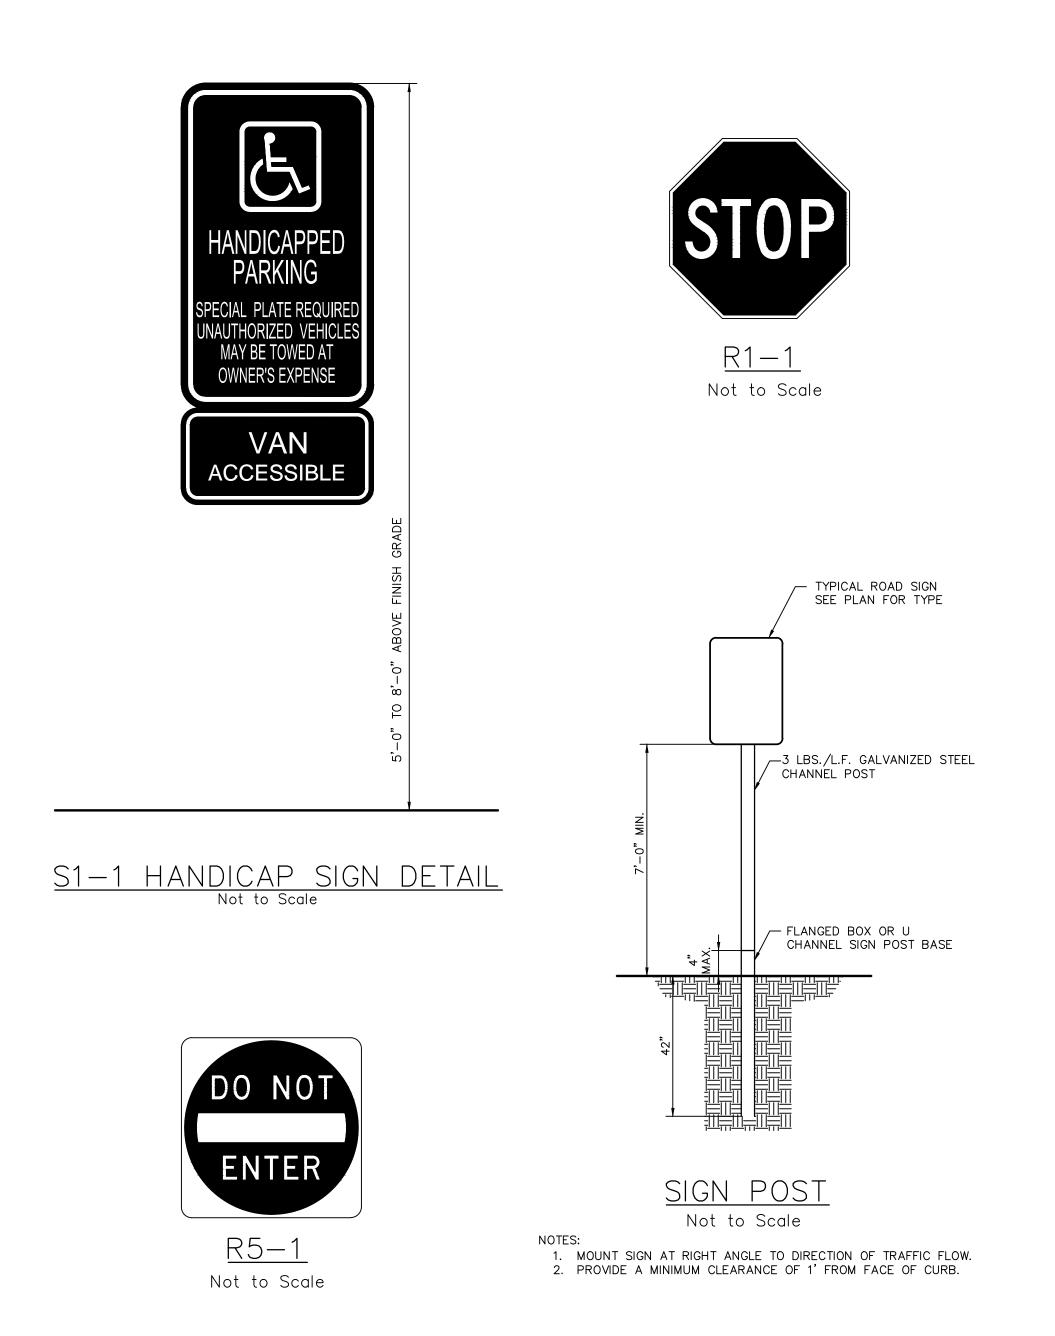

8'-0"

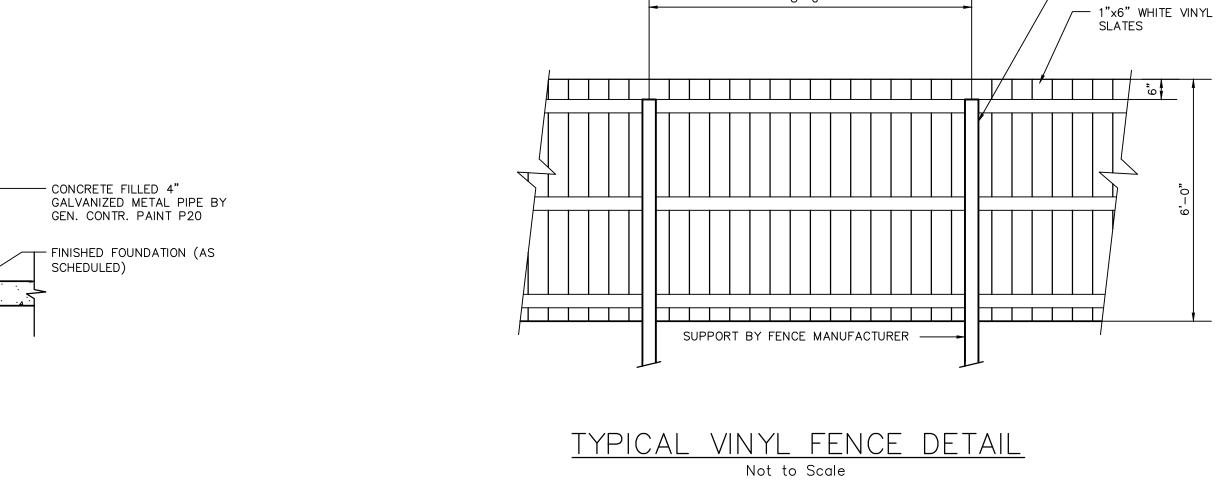

BOLLARD DETAIL


Not to Scale


1'-0"

SHEE ARDNER DETAIL SITE  $\overline{Z}$ PROJECT NO. 1623.113 SHEET NO. AS NOTED DRAWN BY: JJS 12/20/2013

----4"x4" WHITE VINYL COATED POST


AYOUB ENGINEERING EXPRESSLY DISCLAIMS ANY RESPONSIBILITY FOR MONITORING, INSPECTING, OBSERVING, OR SUPERVISING CONSTRUCTION SERVICES, OR THE MEANS, METHODS, SEQUENCES AND TECHNIQUES OF CONSTRUCTION OR FOR JOB SITE SAFETY AND PROGRAMS FOR THE PROJECT DEFINED BY THE PLANS FOR WHICH THIS CERTIFICATION IS AFFIXED. AYOUB HAS NOT BEEN RETAINED FOR NOR SHALL IT HAVE ANY CONTROL OVER OR BE IN CHARGE OF ACTS OR OMISSIONS OF ANY CONTRACTOR, SUBCONTRACTOR, OTHER AGENTS OR EMPLOYEES OR OF ANY OTHER PERSONS PERFORMING PORTIONS OF THE WORK.

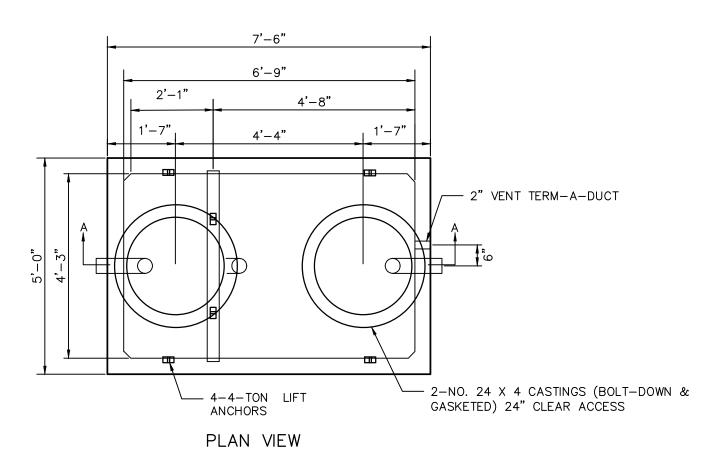

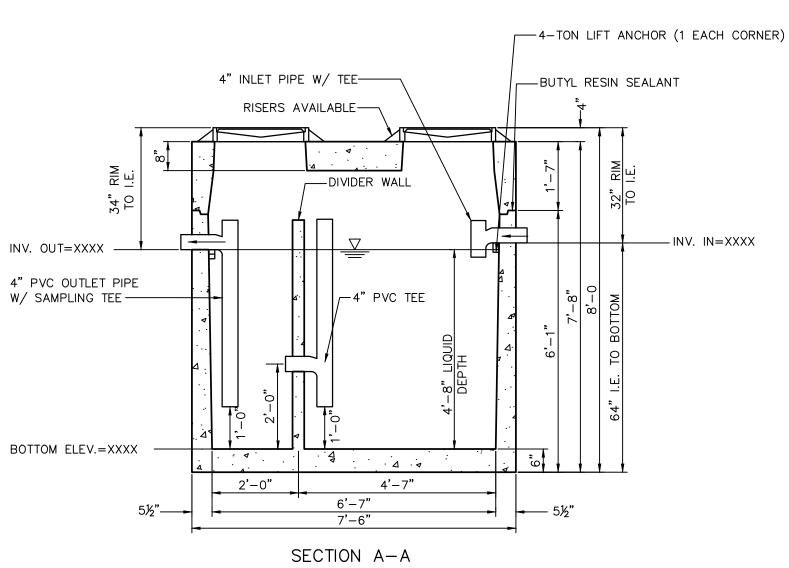

#### GREASE TRAP 1,000 GALLON Not to Scale


- PRECAST CONCRETE GREASE INTERCEPTOR BY OLDCASTLE PRECAST OR EQUIVALENT.
   PRECAST CONCRETE GREASE TRAP MUST CONFORM TO ALL STATE & LOCAL PLUMBING CODES. 3. CONCRETE 28 DAY COMPRESSIVE STRENGTH 5,000 PSI 4. STEEL REINFORCEMENT: ASTM A-615 GRADE 60
- 5. COVER TO STEEL 1" MIN. 6. VAULTS ARE DESIGNED TO MEET ASTM C858 AND ACI 318 WITH AASHTO HS-20 LOADING.
- 7. EARTH COVER 0'-5' MAX. 8. CONSTRUCTION JOINT SEALED WITH 1" DIA. BUTYL RUBBER OR EQUIVALENT.
- 9. DIVIDER WALL TO BE PRECAST CONCRETE. 10. CONTRACTOR TO FILL WITH CLEAN WATER AFTER BACKFILLING IS COMPLETED AND PRIOR TO "START-UP" OF
- SYSTEM. 11. ADD PRECAST RISERS AS NECESSARY TO BRING TO GRADE.

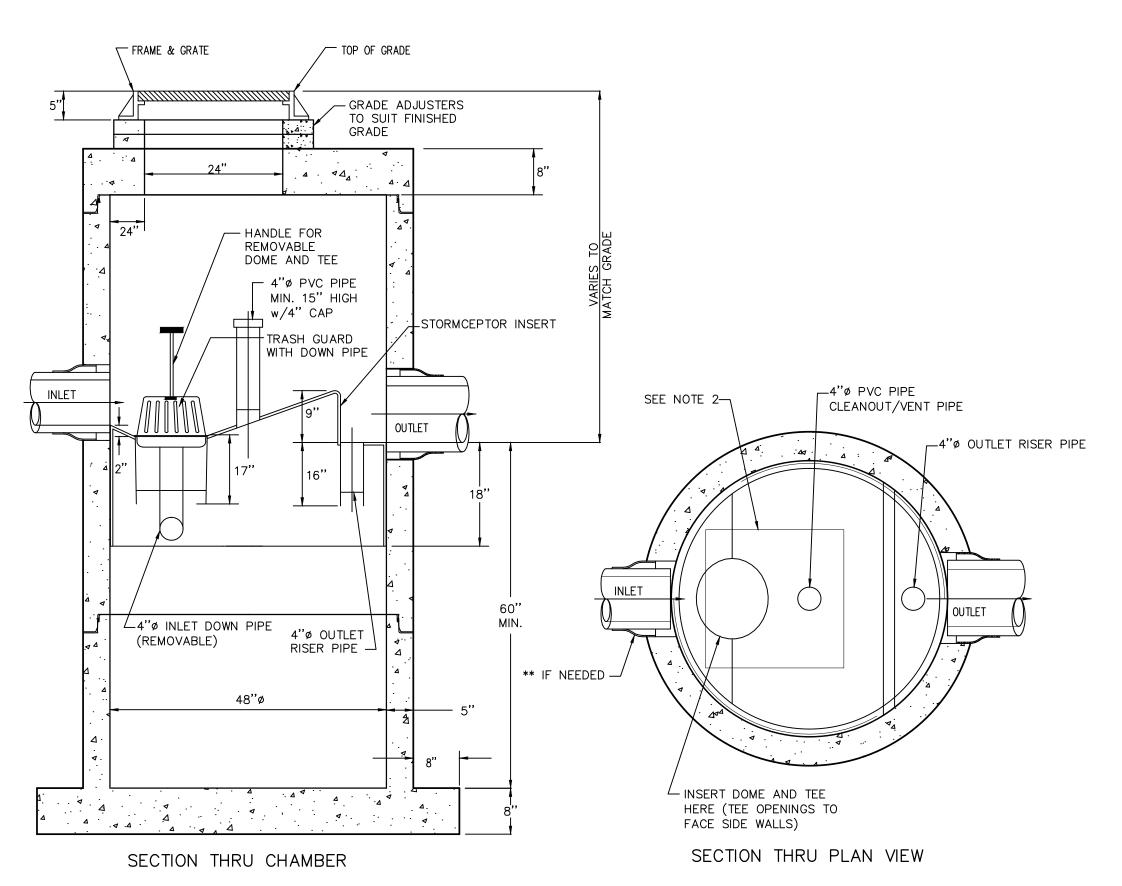


1. THE USE OF FLEXIBLE CONNECTIONS IS RECOMMENDED AT THE OUTLET WHERE APPLICABLE.
2. THE COVER SHOULD BE POSITIONED OVER THE 4"Ø CLEANOUT/VENT PIPE AND THE 4"Ø INLET DOWN

- PIPE.
  3. THE STORMCEPTOR SYSTEM IS PROTECTED BY ONE OR MORE OFF THE FOLLOWING U.S. PATENTS:
- #4985148, #5498331, #5725760, #5753115, #5849181.
- 4. CONTRACTOR TO PROVIDE CRANE TO SET UNIT (HEAVIEST SECTION WEIGHS 5000 LB)

STC 450i PRECAST CONCRETE STORMCEPTOR
450 US GALLON CAPACITY Not to Scale

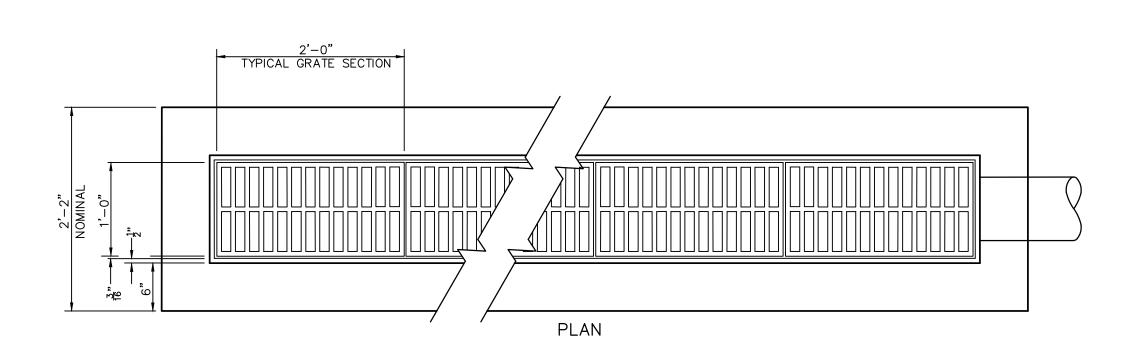

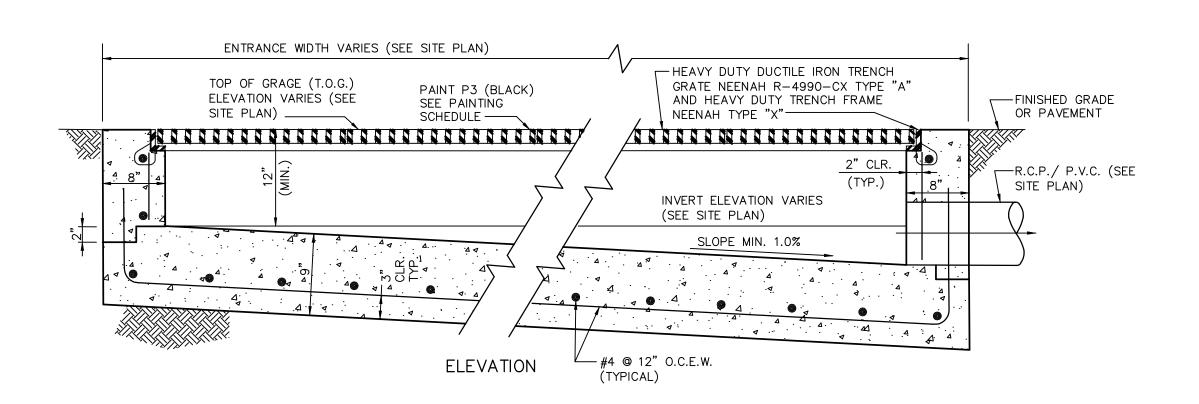



TYPICAL TRENCH DRAIN DETAIL Not to Scale


CONSTRUCTION SERVICES, OR THE MEANS, METHODS, SEQUENCES AND TECHNIQUES OF CONSTRUCTION OR FOR JOB SITE SAFETY AND PROGRAMS FOR THE PROJECT DEFINED BY THE PLANS FOR WHICH THIS CERTIFICATION IS AFFIXED. AYOUB HAS NOT BEEN RETAINED FOR NOR SHALL IT HAVE ANY CONTROL OVER OR BE IN CHARGE OF ACTS OR OMISSIONS OF ANY CONTRACTOR, SUBCONTRACTOR, OTHER AGENTS OR EMPLOYEES OR OF ANY OTHER PERSONS PERFORMING PORTIONS OF THE WORK. S RDNE S PROJECT NO. 1623.113 SHEET NO. AS NOTED DRAWN BY:

12/20/2013

YOUB ENGINEERING EXPRESSLY DISCLAIMS ANY RESPONSIBILITY FOR MONITORING, INSPECTING, OBSERVING, OR SUPERVISING

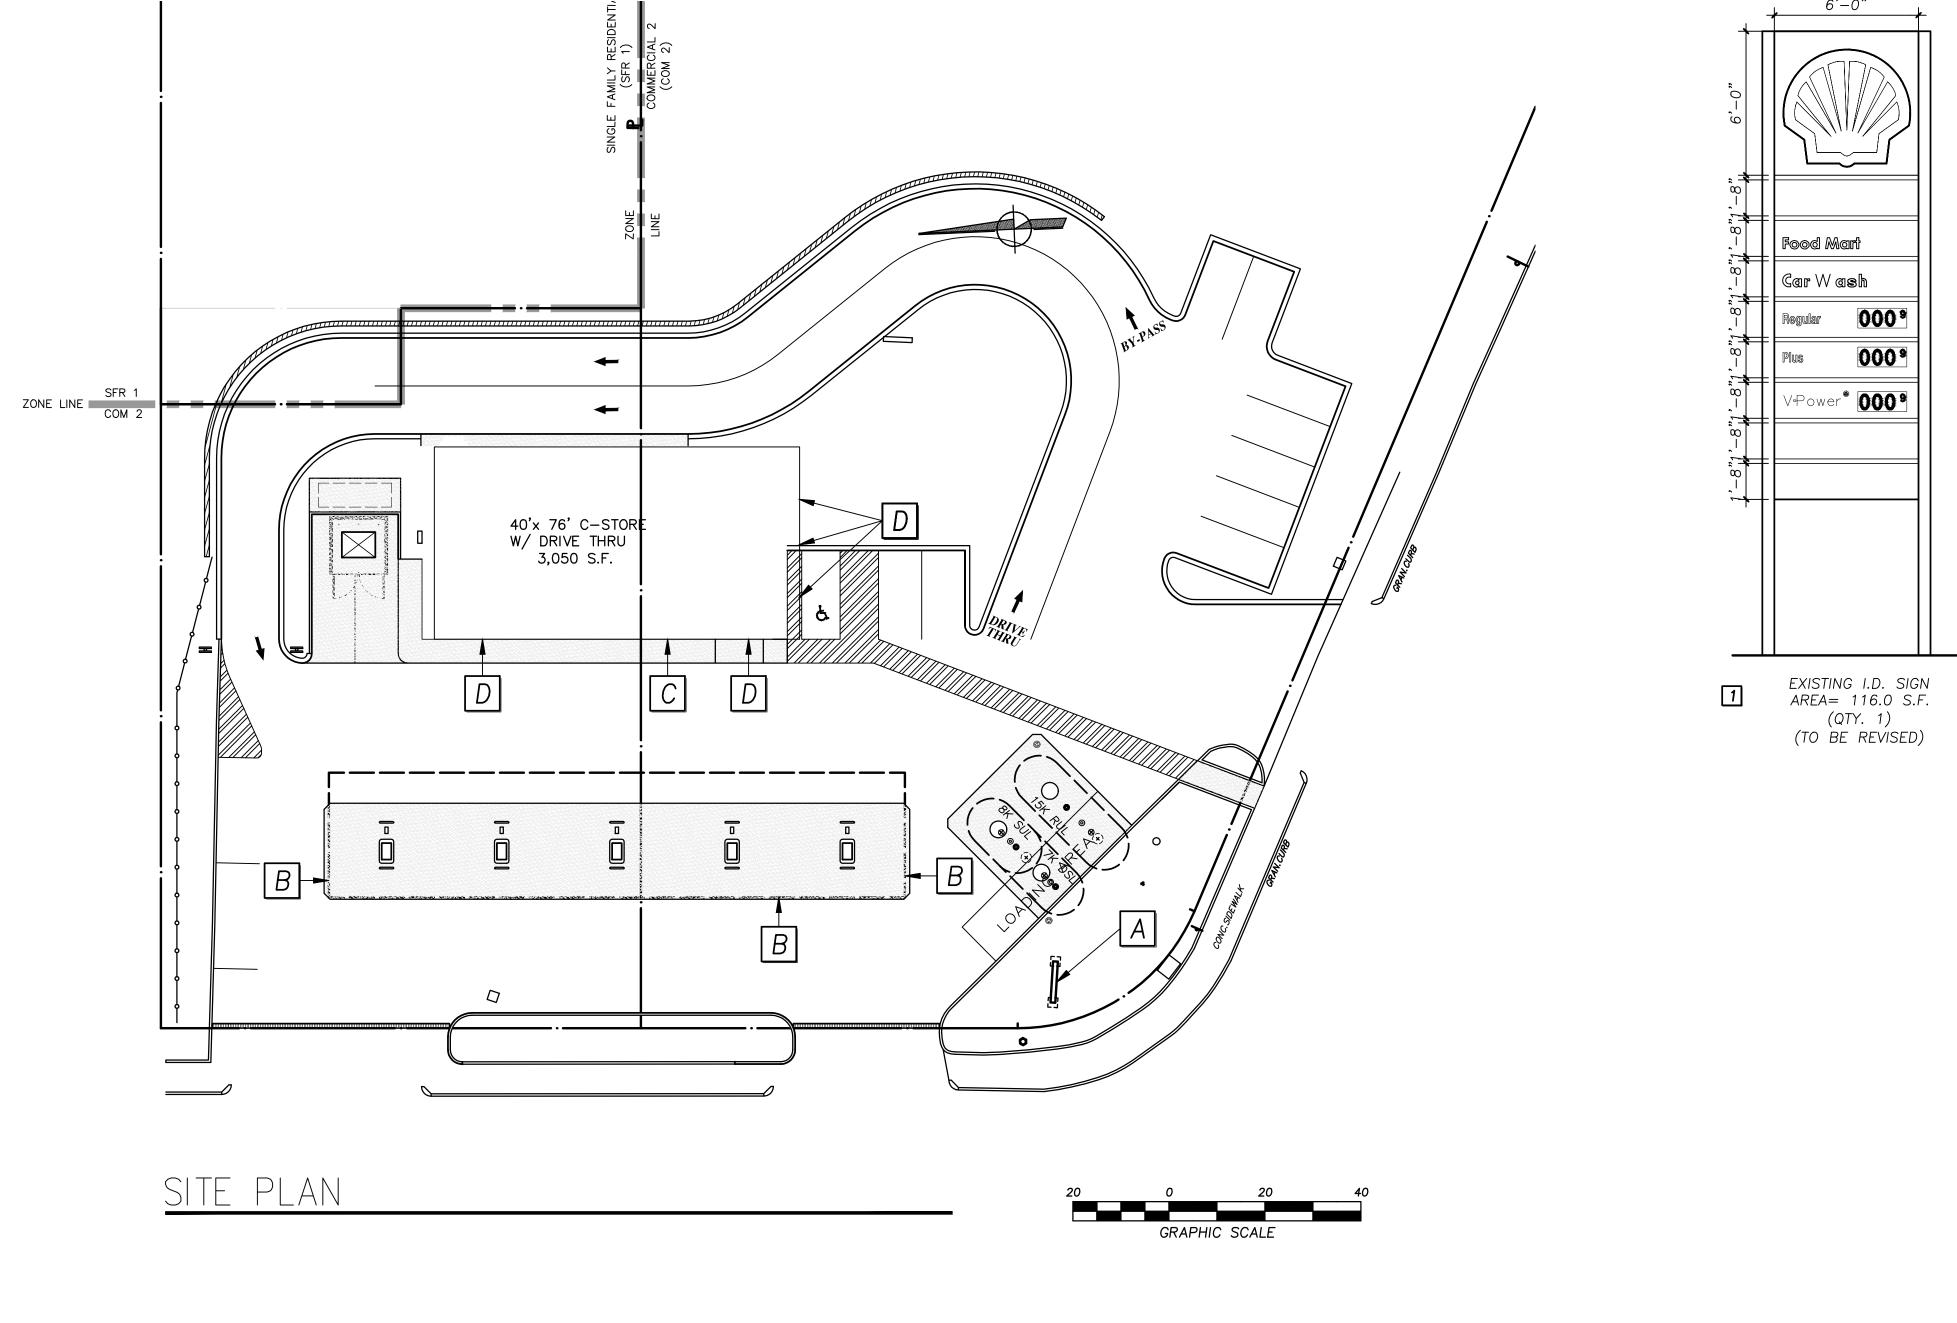

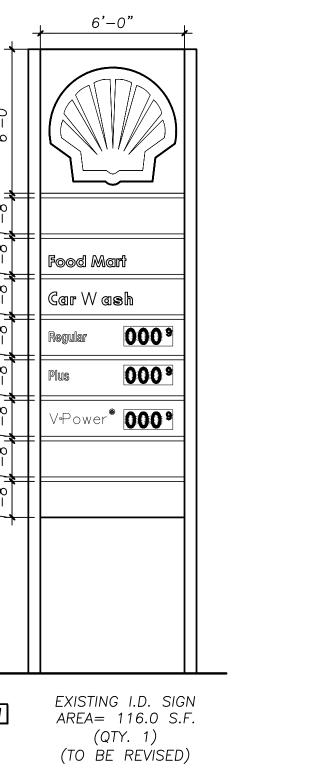

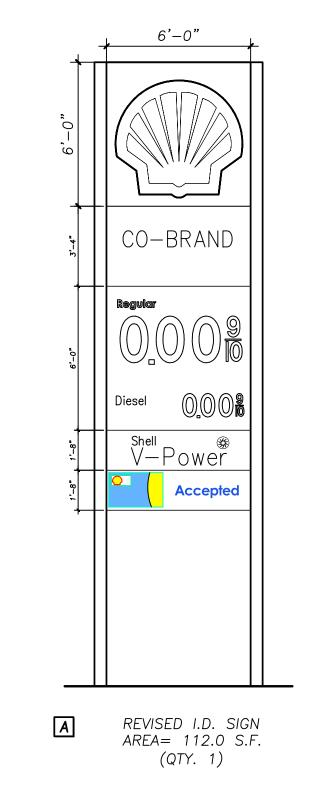

NEW CANOPY SIGN AREA= 15.5 S.F. (QTY. 3)

**GARDNER SHELL** 

NEW BUILDING SIGN AREA= 30.0 S.F. (QTY. 1)

POS NEW POS SIGN AREA= 21.4 S.F.

(QTY. 5)

PROPOSED SIGN SCHEDULE										
MARK	DESCRIPTION	SIZE	AREA (SF)	QUAN.	SIZE (SF)	ILLUMINATION TYPE	REMARKS	TYPE		
WALL/FREESTANDING SIGNS										
В	CANOPY SIGN	3'-11¼" X 3'-11¼"	15.5	3	46.5	INT	NEW	CANOPY		
C	BUILDING SIGN	12'-0" X 2'-6"	30.0	1	30.0	NONE	NEW	WALL		
D	POS SIGN	3'-8" X 5'-10"	21.4	5	107.0	NONE	NEW	WALL		
TOTAL EXISTING SIGN AREA: 183.5										

REFERENCE:

PROPERTY LINES AND OTHER TOPOGRAPHIC INFORMATION SHOWN ON THIS DRAWING WERE TAKEN FROM A PLAN ENTITLED:

EXISTING CONDITIONS PLAN IN GARDNER, MA PREPARED FOR NOURIA ENERGY CORPORATION DATE: AUGUST 22, 2013 SCALE: 1"=20' PREPARED BY: WHITMAN & BINGHAM ASSOCIATES, LLC REGISTERED PROFESSIONAL ENGINEERS & LAND SURVEYORS 510 MECHANIC STREET — LEOMINSTER, MASSACHUSETTS 01453

SIGNA ARDNER, 0 0 ~ PROJECT NO. 1623.113 SHEET NO. AS NOTED DRAWN BY: JJS 12/20/2013

AYOUB ENGINEERING EXPRESSLY DISCLAIMS ANY RESPONSIBILITY FOR MONITORING, INSPECTING, OBSERVING, OR SUPERVISING CONSTRUCTION SERVICES, OR THE MEANS, METHODS, SEQUENCES AND TECHNIQUES OF CONSTRUCTION OR FOR JOB SITE SAFETY AND PROGRAMS FOR THE PROJECT DEFINED BY THE PLANS FOR WHICH THIS CERTIFICATION IS AFFIXED. AYOUB HAS NOT BEEN RETAINED FOR NOR SHALL IT HAVE ANY CONTRACTOR. SUBCONTRACTOR

ACTS OR OMISSIONS OF ANY CONTRACTOR, SUBCONTRACTOR, OTHER AGENTS OR EMPLOYEES OR OF ANY OTHER PERSONS PERFORMING PORTIONS OF THE WORK.

